FOR INDEX OF SHEETS, SEE SHEET NO. 2 FOR LIST OF HIGHWAY STANDARDS SEE SHEET NO. 2

TRAFFIC DATA

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ADT: SEMINARY St 3,750 VPD (2008)

SPEED POSTED DESIGN SPEED

SEMINARY St

DESIGN DESIGNATION


Seminary St - MINOR ARTERIAL (NON-URBAN)

COUNTY OF WINNEBAGO CITY OF ROCKFORD

PLANS FOR PROPOSED SEMINARY STREET RESURFACING

NORTH OF CATHERINE STREET TO SOUTH OF BREMER STREET



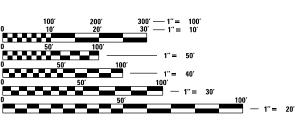


FULL SIZE PLANS HAVE BEEN PREPARED USING STANDARD **ENGINEERING SCALES. REDUCED SIZED PLANS WILL NOT** CONFORM TO STANDARD SCALES. IN MAKING MEASUREMENTS ON REDUCED PLANS, THE ABOVE SCALES MAY BE USED.

 \circ

JOINT UTILITY LOCATION INFORMATION FOR EXCAVATION 1-800-892-0123

PROJECT ENGINEER: J. HORWITZ PROJECT MANAGER: J. MELHUISH

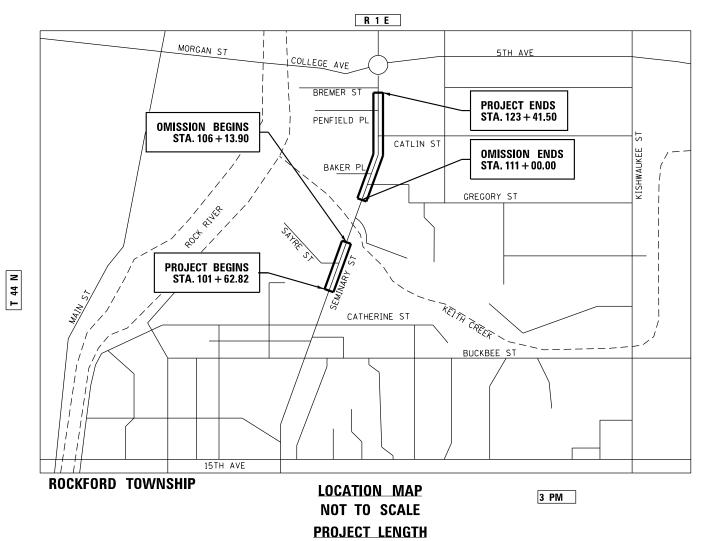

LOCATION OF SECTION INDICATED THUS: -420 NORTH FRONT STREET, SUITE 100 | McHENRY, ILLINOIS 60050 Phone: 815.385.1778 | Toll Free: 800.728.7805 | Fax: 815.385.1781 | HRGreen.com ILLINOIS PROFESSIONAL DESIGN FIRM #184-001322

WINNEBAGO

FED. ROAD DIST. NO 2 ILLINOIS CONTRACT NO.

CITY OF ROCKFORD

GROSS LENGTH OF PROJECT = 2179 FT. = 0.31 MILES NET LENGTH OF PROJECT = 1693 FT. = 0.32 MILES

INDEX OF SHEETS

SHEE	T NUN	/IBER	DESCRIPTION
1			COVER SHEET
2			INDEX OF SHEETS, HIGHWAY STANDARDS, AND GENERAL NOTES
3			SUMMARY OF QUANTITIES
4			TYPICAL SECTIONS
5	-	6	REMOVAL PLAN
7	-	8	RESURFACING PLAN
9			CITY OF ROCKFORD DETAIL COMBINATION CONCRETE CURB AND GUTTER TYPE M6.18 (MODIFIED)
10	-	13	WORK ZONE SIGN DETAILS
14	-	16	TYPICAL PAVEMENT MARKINGS

STATE STANDARDS

STANDARD NO	LIST OF DESCRIPTION
000001-08	STANDARD SYMOBLS, ABBREVIATIONS AND PATTERNS
001006	DECIMAL OF AN INCH AND OF A FOOT
280001-07	TEMPORARY EROSION CONTROL SYSTEMS
424001-11	PERPENDICULAR CURB RAMPS FOR SIDEWALKS
424006-05	DIAGONAL CURB RAMPS FOR SIDEWALKS
424011-04	CORNER PARALLEL CURB RAMPS FOR SIDEWALKS
242016-05	MID-BLOCK CURB RAMPS FOR SIDEWALKS
424021-06	DEPRESSED CORNER FOR SIDEWALKS
442201-03	CLASS C AND D PATCHES
602001-02	CATCH BASIN TYPE A
602011-02	CATCH BASIN TYPE C
602406-11	PRECAST MANHOLE TYPE A 6' (1.83 m) DIAMETER
602701-02	MANHOLE STEPS
604001-05	FRAME AND LIDS TYPE 1
604006-05	FRAME AND GRATE TYPE 3
606001-07	CONCRETE CURB TYPE B AND COMBINATION CONCRETE CURB AND GUTTER
606301-04	PC CONCRETE ISLANDS AND MEDIANS
701001-02	OFF-RD OPERATIONS, 2L, 2W, MORE THAN 15' (4.5M) AWAY
701301-04	LANE CLOSURE, 2L, 2W, SHORT TIME OPERATIONS
701311-03	LANE CLOSURE 2L, 2W, MOVING OPERATIONS-DAY ONLY
701801-06	SIDEWALK, CORNER OR CROSSWALK CLOSURE
701901-08	TRAFFIC CONTROL DEVICES
720011-01	METAL POSTS FOR SIGNS, MARKERS & DELINEATORS
728001-01	TELESCOPING STEEL SIGN SUPPORT
729001-01	APPLICATIONS OF TYPES A & B METAL POSTS (FOR SIGNS AND MARKERS)
780001-05	TYPICAL PAVEMENT MARKINGS
B.L.R. 21-9	TYPICAL APPLICATION OF TRAFFIC CONTROL DEVICES FOR CONSTRUCTION ON RURAL LOCAL HIGHWAYS

DISTRICT TWO DETAILS

DISTRICT 2 STANDARDS

STANDARD NO LIST OF DESCRIPTION WORK ZONE SIGN DETAILS 34.1 41.1 TYPICAL PAVEMENT MARKINGS

HRGreen.com **HRGreen**

USER NAME = jhorwit	DESIGNED	-	JCH	REVISED	-	XX/XX/XXXX
	DRAWN	-	CL	REVISED	-	XX/XX/XXXX
PLOT SCALE = 2.0000 '/ in.	CHECKED	-	JRM	REVISED	-	XX/XX/XXXX
PLOT DATE = 6/23/2022	DATE	-	6/22/2022	REVISED	-	XX/XX/XXXX

CITY OF ROCKFORD

SECTION NO. COUNTY SEMINARY STREET 5112 WINNERAGO 16 INDEX OF SHEETS, HIGHWAY STANDARDS & GENERAL NOTES CONTRACT NO. SCALE: N.T.S. SHEET 1 OF 1 SHEETS STA. FED. ROAD DIST, NO. | ILLINOIS FED. AID PROJECT

GENERAL NOTES

- ALL REFERENCES TO "STANDARD SPECIFICATIONS" IN THESE GENERAL NOTES SHALL BE INTERPRETED TO MEAN "STANDARD SPECIFICATIONS FOR ROAD AND BRIDGE CONSTRUCTION" ADOPTED BY THE ILLINOIS DEPARTMENT OF TRANSPORTATION, APRIL 1, 2020. ALL WORK TO BE COMPLETED IN ACCORDANCE WITH THE STANDARD SPECIFICATIONS.
- BEFORE STARTING ANY EXCAVATION, THE CONTRACTOR SHALL CALL "JULIE" (JOINT UTILITY LOCATION INFORMATION FOR EXCAVATION) AT 8-1-1 FOR FIELD LOCATIONS OF BURIED UTILITIES (48 HOURS
- 3. ALL ELEVATIONS SHOWN ON THE PLANS ARE ON THE NAVD 88 DATUM.
- 4. OFFSET LOCATIONS GIVEN IN THE PLANS FOR STRUCTURES, EDGE OF PAVEMENT, ETC. ARE FROM THE ROADWAY CENTERLINE.
- 5. SAW CUTTING OF PAVEMENTS, CURB AND GUTTER, SIDEWALK, ETC. SHALL BE TO FULL DEPTH AND SHALL RESULT IN A CLEAN STRAIGHT EDGE ON THE PORTION REMAINING
- MATERIALS RESULTING FROM THE REMOVAL OF ASPHALT SURFACES, CONCRETE REMOVAL, UTILITY STRUCTURE ADJUSTMENTS, GRADING WORK, ETC. SHALL BE REMOVED AT THE END OF EACH DAY TO AN APPROVED SITE. IN THE JUDGEMENT OF THE ENGINEER, SHOULD IT BE RECESSARY TO REMOVE SUCH MATERIALS, THE ENGINEER WILL HAVE THE MATERIAL REMOVED AND THE CONTRACTOR SHALL HAVE THE DOLLAR AMOUNT REDUCED FROM THE NEXT PAY ESTIMATE.
- 7. SIDEWALK REMOVAL AND REPLACEMENT, DRIVEWAY REMOVAL AND REPLACEMENT, AND COMBINATION CONCRETE CURB AND GUTTER REMOVAL AND REPLACEMENT AS SHOWN ON THE PLANS IS FOR INFORMATIONAL PURPOSES ONLY. ACTUAL LOCATIONS AND QUANTITIES TO BE DETERMINED AND MARKED BY THE ENGINEER PRIOR TO CONSTRUCTION.
- 8. ALL BRICKS ENCOUNTERED IN THE ROADWAY SHALL BE REMOVED, PALLETIZED, AND DELIVERED TO THE CITY YARDS AT 524 S CENTRAL AVE. THIS WORK WILL BE PAID FOR AS BRICK PAVER REMOVAL

- STORM SEWERS, WATER MAINS, AND UTILITIES
 THE CONTRACTOR SHALL BE RESPONSIBLE FOR CONTACTING THE OWNERS OF ALL UTILITIES PRIOR TO
 CONSTRUCTION TO DETERMINE THE LOCATION OF ALL UTILITY EQUIPMENT. THE CONTRACTOR SHALL COOPERATE WITH ALL UTILITY OWNERS IN ACCORDANCE WITH THE STANDARD SPECIFICATIONS IF UTILITY RELOCATION, ADJUSTMENT, OR PROTECTION IS NECESSARY.
- 2. THE LOCATION OF EXISTING DRAINAGE STRUCTURES, STORM SEWERS, WATER MAINS, SANITARY SEWERS, AND ANY OTHER PUBLIC OR PRIVATE UTILITIES AS SHOWN ON THE PLANS IS APPROXIMATE AND THEIR EXACT LOCATION IS TO BE DETERMINED IN THE FIELD BY THE CONTRACTOR.
- THE CONTRACTOR SHALL BE RESPONSIBLE FOR THE PROTECTION OF ALL UNDERGROUND AND SURFACE UTILITIES EVEN THOUGH THEY MIGHT NOT BE SHOWN ON THE PLANS. ANY UTILITY PROPERTY DAMAGED DURING CONSTRUCTION SHALL BE REPAIRED OR REPLACED TO THE SATISFACTION OF THE OWNER AT THE CONTRACTOR'S EXPENSE.
- 4. THE CONTRACTOR SHALL USE ALL NECESSARY PRECAUTIONS AND PROTECTION MEASURES REQUIRED TO MAINTAIN EXISTING UTILITIES, SEWERS, AND APPURTENANCES THAT MUST BE KEPT IN OPERATION
- 5. ANY LOOSE MATERIAL DEPOSITED IN THE FLOW LINE OF DRAINAGE STRUCTURES, WHICH OBSTRUCTS THE NATURAL FLOW OF WATER SHALL BE REMOVED AT THE CLOSE OF EACH WORKING DAY. PRIOR TO ACCEPTANCE OF THE IMPROVEMENT, ALL DRAINAGE STRUCTURES SHALL BE FREE OF DIRT AND DEBRIS.
- 6. ALL FRAMES, GRATES, LIDS, AND BOXES SCHEDULED TO BE REMOVED FROM EXISTING STRUCTURES SHALL REMAIN THE PROPERTY AND BE DELIVERED TO THE ENGINEERING DEPARTMENT. THE PHONE NUMBER FOR
- 7. ALL FRAMES WITH CLOSED LIDS TO BE FURNISHED AS PART OF THE CONTRACT FOR CONSTRUCTION, ADJUSTMENT OR RECONSTRUCTION OF ANY MANHOLE, CATCH BASIN, OR INLET, SHALL HAVE CAST INTO THE LID ONE OF THE FOLLOWING WORDS: ALL LIDS TO BE USED ON STORM SEWER STRUCTURES SHALL BEAR
- 8. THE INDISCRIMINATE USE OF FIRE HYDRANTS OR EXISTING STREAMS, CREEKS, WETLANDS OR PONDS IS STRICTLY PROHIBITED. THE CONTRACTOR SHALL PROVIDE A WATER TRUCK AND DRIVER AS REQUIRED TO OBTAIN AND TRANSPORT THIS WATER. THE CONTRACTOR SHALL BE RESPONSIBLE FOR OBTAINING WATER FROM AN APPROVED SOURCE. IF THIS WATER IS FROM A SOURCE OTHER THAN HIS YARD, WRITTEN APPROVAL FROM THE AGENCY HAVING JURISDICTION FOR THE SOURCE OF THE WATER MUST BE RECEIVED BY THE ENGINEER PRIOR TO USE OF THE WATER.

SIGNING AND STRIPING

1. SEE IDOT DISTRICT TWO DETAILS AND PLAN SHEETS FOR PAVEMENT MARKING DETAILS.

- SEQUENCE OF CONSTRUCTION ROADWAY
 IT WILL BE THE CONTRACTOR'S RESPONSIBILITY TO NOTIFY RESIDENTS AND THE CITY WHEN ACCESS TO THEIR DRIVEWAYS WILL BE TEMPORARILY CLOSED DUE TO CONCRETE CURB AND GUTTER INSTALLATION OR SIDEWALK CONSTRUCTION. AT LOCATIONS WHERE NEW GUTTER OR SIDEWALK IS TO BE INSTALLED ACROSS A DRIVEWAY, THE CONTRACTOR SHALL CONTACT THE PROPERTY OWNER 48 HOURS PRIOR TO REMOVING THE PAVEMENT. THE CONTRACTOR SHALL DISTRIBUTE NOTICES, PROVIDED BY THE CITY, TO RESIDENTS. EVERY EFFORT SHALL BE MADE TO ACCOMODATE ACCESS TO THESE PROPERTIES (KNOCK ON DOORS WHEN ADDITIONAL TO ACCOMODATE ACCESS TO THESE PROPERTIES (KNOCK ON DOORS WHEN A DRIVEWAY IS ABOUT TO BE CLOSED).
- 2. THE CONTRACTOR SHALL NOT BE ALLOWED TO CLOSE A DRIVEWAY FOR MORE THAN 48 HOURS UNDER ANY CIRCUMSTANCES. THE CONTRACTOR SHALL BE RESPONSIBLE FOR MAINTAINING BARRICADES TO PREVENT TRAFFIC FROM USING DRIVEWAYS DURING THIS PERIOD

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#164-001322

* SPECIAL PROVISION

PAYCODE

11

18

25

33

34

41

REMOVAL AND DISPOSAL OF UNSUITABLE MATERIAL

AGGREGATE SUBGRADE IMPROVEMENT 12"

SUBBASE GRANULAR MATERIAL, TYPE B 6"

MIXTURE FOR CRACKS, JOINTS, AND FLANGEWAYS

HOT-MIX ASPHALT BINDER COURSE, IL-19.0, N50; 4" & VARIES

PORTLAND CEMENT CONCRETE DRIVEWAY PAVEMENT, 8 INCH

HOT-MIX ASPHALT SURFACE REMOVAL - BUTT JOINT

HOT-MIX ASPHALT SURFACE COURSE, MIX "D", N50

HOT-MIX ASPHALT PAVEMENT (FULL-DEPTH), 8"

PORTLAND CEMENT CONCRETE SIDEWALK 5 INCH

HOT-MIX ASPHALT SURFACE REMOVAL, 2"

COMBINATION CURB AND GUTTER REMOVAL

BITUMINOUS MATERIALS (TACK COAT)

LONGITUDINAL JOINT SEALANT

DETECTABLE WARNINGS

BRICK PAVER REMOVAL

SIDEWALK REMOVAL

MEDIAN REMOVAL

DRIVEWAY PAVEMENT REMOVAL

CLASS D PATCHES, TYPE I. 7 INCH

CLASS D PATCHES, TYPE II, 7 INCH

CLASS D PATCHES, TYPE IV. 7 INCH

STORM SEWERS, CLASS A, TYPE 2 12"

STORM SEWERS, CLASS A, TYPE 2 15"

CATCH BASINS, TYPE A, 4'-DIAMETER, TYPE 3 FRAME AND GRATE

MANHOLES, TYPE A, 6'-DIAMETER, TYPE 1 FRAME, CLOSED LID

COMBINATION CONCRETE CURB AND GUTTER, TYPE B-6.12

TRAFFIC CONTROL AND PROTECTION, STANDARD 701601
TRAFFIC CONTROL AND PROTECTION, STANDARD 701701

TRAFFIC CONTROL AND PROTECTION, STANDARD 701801

COMBINATION CONCRETE CURB AND GUTTER, TYPE M-6.18 (MOD.)

INLETS TO BE RECONSTRUCTED WITH NEW TYPE 1 FRAME, CLOSED LID

FRAME AND LIDS TO BE ADJUSTED WITH NEW TYPE I FRAME, CLOSED LID

CATCH BASINS, TYPE C. TYPE 3 FRAME AND GRATE

STORM SEWER REMOVAL 15"

INLETS TO BE ADJUSTED

CONCRETE CURB, TYPE B

CONCRETE MEDIAN SURFACE, 4 INCH

PAVEMENT REMOVAL

SEEDING (SPECIAL)

CITY	OF	ROCKFORD	

ROADWAY

100% LOCAL

112

757

141

1,188

5,015

50

1,693

1,663

63

832

96

136

9,057

155

525

7,423

7,948

136

1,409

9,095

363

160

80

30

1,609

170

415

UNIT

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L SUM

TOTAL

112

757

141

1,188

5,015

50

1,693

63

832

96

136

9,057

155

525

7,423

7.948

136

1,409

9,095

363

400

80

30

116

1,609

170

415

PAYCODE TEM DESCRIPTION 42 SHORT TERM PAVEMENT MARKING 43 SHORT TERM PAVEMENT MARKING REMOVAL 44 SIGN PANEL - TYPE 1 45 REMOVE SIGN PANEL ASSEMBLY - TYPE A 46 TELESCOPING STEEL SIGN SUPPORT 47 THERMOPLASTIC PAVEMENT MARKING - LINE 4" 48 THERMOPLASTIC PAVEMENT MARKING - LINE 6" 49 THERMOPLASTIC PAVEMENT MARKING - LINE 8" 50 THERMOPLASTIC PAVEMENT MARKING - LINE 2" 51 THERMOPLASTIC PAVEMENT MARKING - LINE 24" 52 CONSTRUCTION LAYOUT (SPECIAL) 53 MOBILIZATION 54 CONNECTION TO EXISTING SEWER 55 WASHOUT BASIN 56 TEMPORARY ACCESS (PRIVATE ENTRANCE) 57 TEMPORARY INFORMATION SIGNING	42 SHORT TERM PAVEMENT MARKING 43 SHORT TERM PAVEMENT MARKING REMOVAL 44 SIGN PANEL - TYPE 1 45 REMOVE SIGN PANEL ASSEMBLY - TYPE A 46 TELESCOPING STEEL SIGN SUPPORT 47 THERMOPLASTIC PAVEMENT MARKING - LINE 4" 48 THERMOPLASTIC PAVEMENT MARKING - LINE 6" 49 THERMOPLASTIC PAVEMENT MARKING - LINE 8" 50 THERMOPLASTIC PAVEMENT MARKING - LINE 12" 51 THERMOPLASTIC PAVEMENT MARKING - LINE 12" 52 CONSTRUCTION LAYOUT (SPECIAL) 53 MOBILIZATION 54 CONNECTION TO EXISTING SEWER 55 WASHOUT BASIN			
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56 TEMPORARY ACCESS (PRIVATE ENTRANCE)	56 TEMPORARY ACCESS (PRIVATE ENTRANCE)		CONNECTION TO EXISTING SEWER	
		54		
57 TEMPORARY INFORMATION SIGNING	57 TEMPORARY INFORMATION SIGNING			
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		55 56	WASHOUT BASIN TEMPORARY ACCESS (PRIVATE ENTRANCE)	

ROADWAY

100% LOCAL

471

275

3,409

303

74

47

471

275


3,409

303

74

47

52

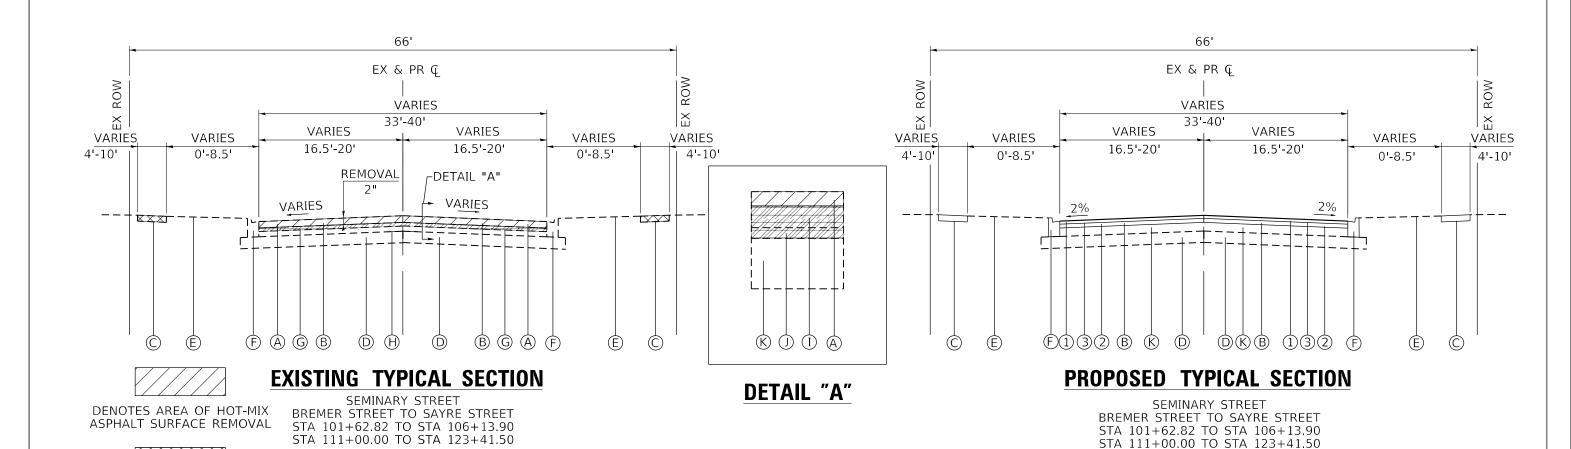

DENOTES AREA OF SIDEWALK REMOVAL

DENOTES AREA OF BRICK PAVER REMOVAL

EXISTING LEGEND

- (A) HOT-MIX ASPHALT SURFACE REMOVAL, 2"
- (B) HOT-MIX ASPHALT PAVEMENT/BRICK, (13 ½" & VARIES)
- © PORTLAND CEMENT CONCRETE SIDEWALK (SPOT REMOVAL & REPLACEMENT AS DIRECTED BY THE ENGINEER)
- D AGGREGATE SUBBASE
- **E** EXISTING GROUND
- (F) COMBINATION CONCRETE CURB & GUTTER, TYPE M-6.18 (MOD.) (SPOT REMOVAL & REPLACEMENT AS DIRECTED BY THE ENGINEER)
- (G) BRICK PAVER REMOVAL (SEE GENERAL NOTE 8)
- (H) LONGITUDINAL JOINT SEALER
- (I) VITRIFIED BRICK (3" & VARIES)
- \bigcirc SAND CUSHION (1½" & VARIES)
- (K) CONCRETE BASE (7" & VARIES)

PROPOSED LEGEND

- (1) HMA SURFACE COURSE, MIX "D", N50; 2"
- ② HMA BINDER COURSE, IL-19.0, N50; 4" & VARIES
- (3) BITUMINOUS MATERIALS (TACK COAT)

HOT-MIX ASPHALT MIXTURE REQUIREMENTS	
MIXTURE TYPE	AIR VOIDS @ Ndes
PAVEMENT RESURFACING	
HMA SURFACE COURSE, MIX "D", N50; 2"	3.5% @ 50 GYR.
HMA BINDER COURSE, IL-19.0, N50; 4" & VARIES	3.5% @ 50 GYR.
HOT-MIX ASPHALT PAVEMENT (FULL-DEPTH), 8"	
HMA SURFACE COURSE, MIX "D", N50; 2"	3.5% @ 50 GYR.
HMA BINDER COURSE, IL-19.0, N50; 2"	3.5% @ 50 GYR.
HOT-MIX ASPHALT BASE COURSE (HMA BINDER IL-19mm); 4"	3.5% @ 50 GYR.
PATCHING (see note)	
CLASS D PATCHES, (HMA BINDER, IL-19mm)	3.5% @ 50 GYR.

NOTES: THE PATCHING QUANTITIES HAVE BEEN ESTIMATED BASED ON FIELD OBSERVATION DURING DESIGN. ACTUAL QUANTITIES TO BE DETERMINED DURING CONSTRUCTION BY THE ENGINEER.

: 1		
ייי יייי	HRGreen.	HRGreen.com Illinois Professional Design FI # 184-001322


USER NAME = jhorwit	DESIGNED	-	JCH	REVISED -	
	DRAWN	-	CL	REVISED -	
PLOT SCALE = 20.0000 '/ 10.	CHECKED	-	JRM	REVISED -	
PLOT DATE = 6/23/2022	DATE	-	6/22/2022	REVISED -	

					IARY ST Al Sect		
SCALE: N.T.S.	SHEET	1	OF	1	SHEETS	STA.	

	F.A.U RTE.		SECTIO	N NO.		COUNTY	TOTAL	SHEET NO.
	5112					WINNEBAGO	15	4
						CONTRACT	NO.	
TO STA.	FED. RO	DAD DIST.	NO.	ILLINOIS	FED. AI	PROJECT		


RG PROJECT NO. 180909 RG PROJ. CONTACT: LE NAME: 180909. sht. typ-resurf.c LOT DRIVER: IL.pdf.bw.pltcfg

CITY OF ROCKFORD

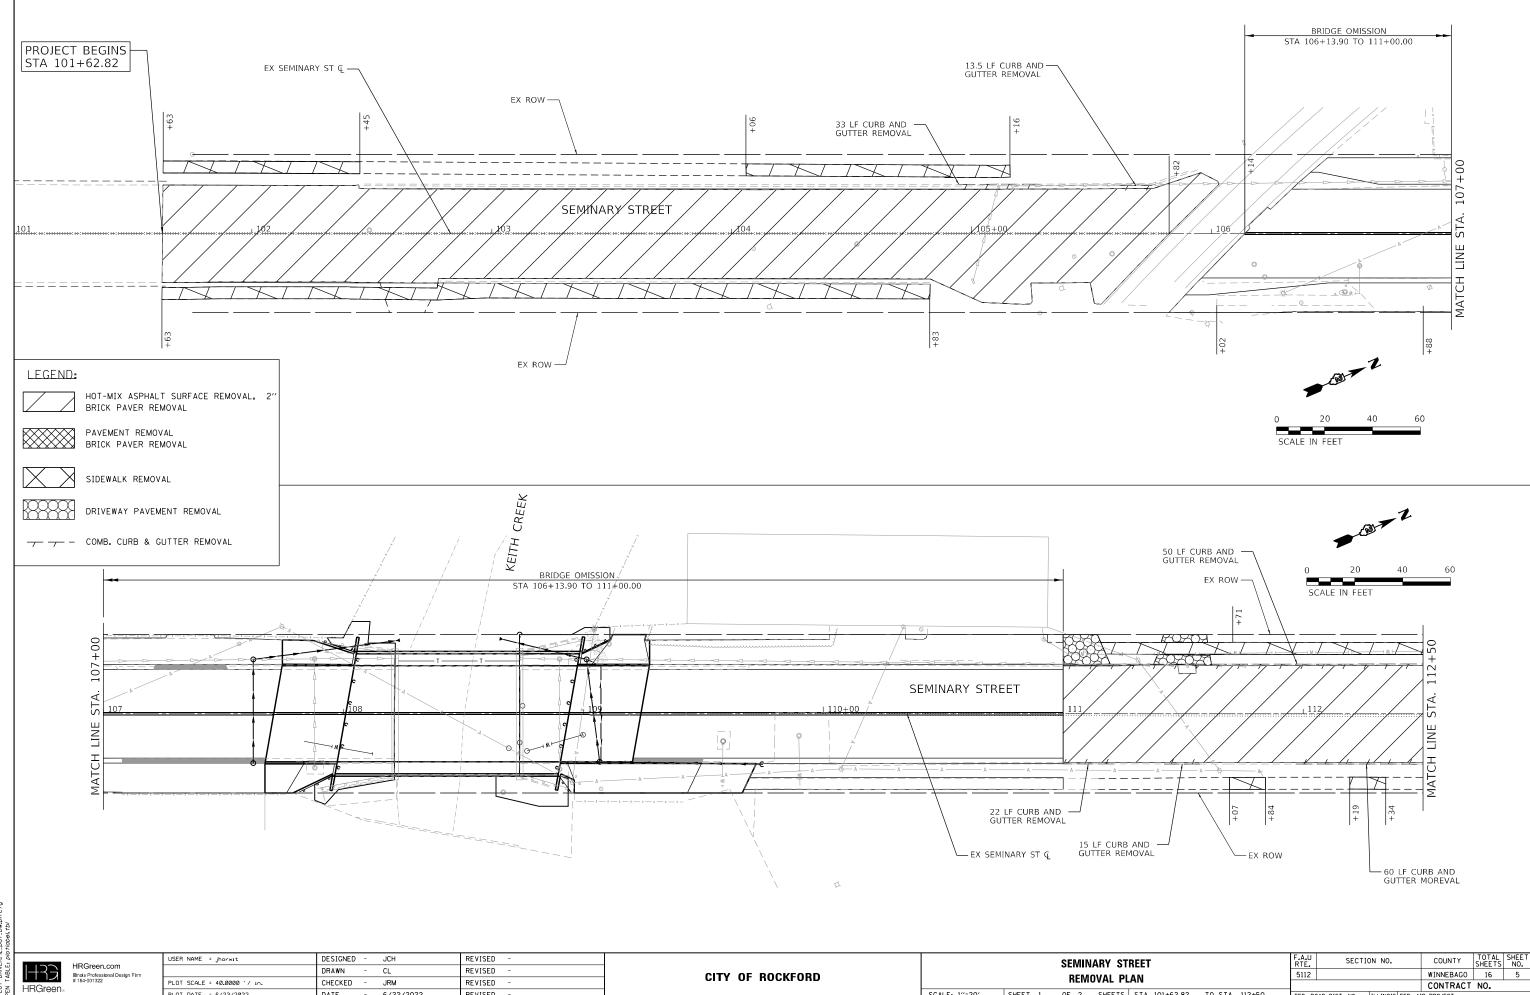


CHECKED JRM REVISED PLOT DATE = 6/23/2022 REVISED DATE 6/22/2022

CONTRACT NO. SCALE: 1"=20' SHEET 1 OF 2 SHEETS STA. 101+62.82 TO STA. 112+50 FED. ROAD DIST. NO. | ILLINOIS FED. AID PROJECT

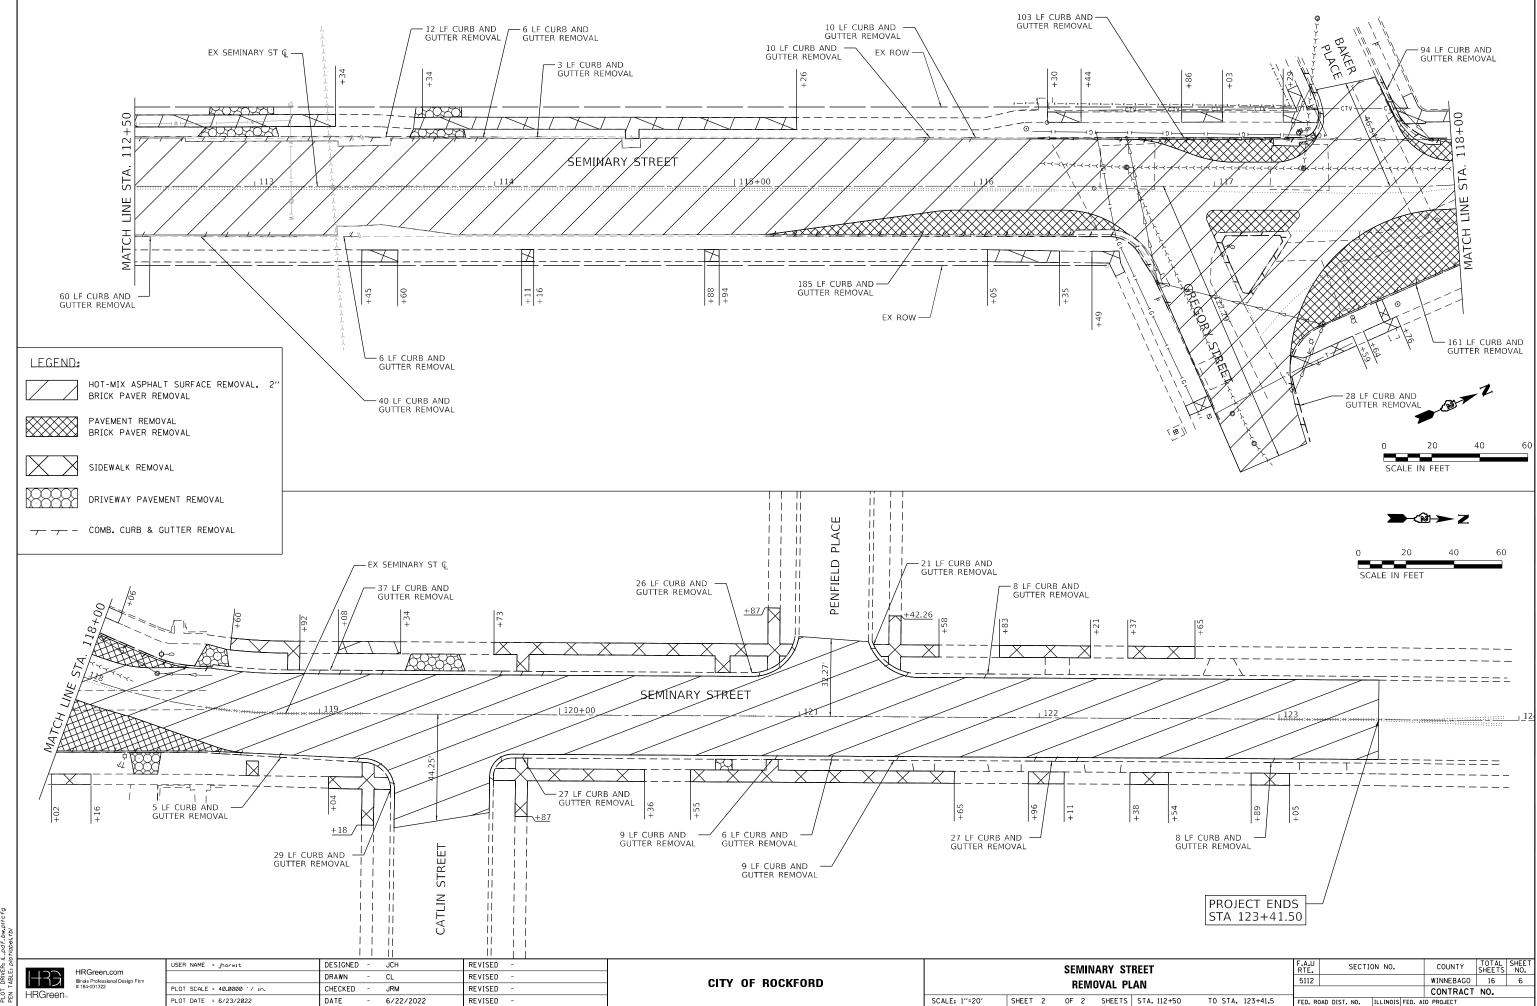

HRG PROJECT NO., 180909
HRG PROJ. CONTACT.
FILE NAME, 180909, sht, resurt, rem., 02, dgn
PLOT DRIVER! IL. pdf., bw.pitcfg

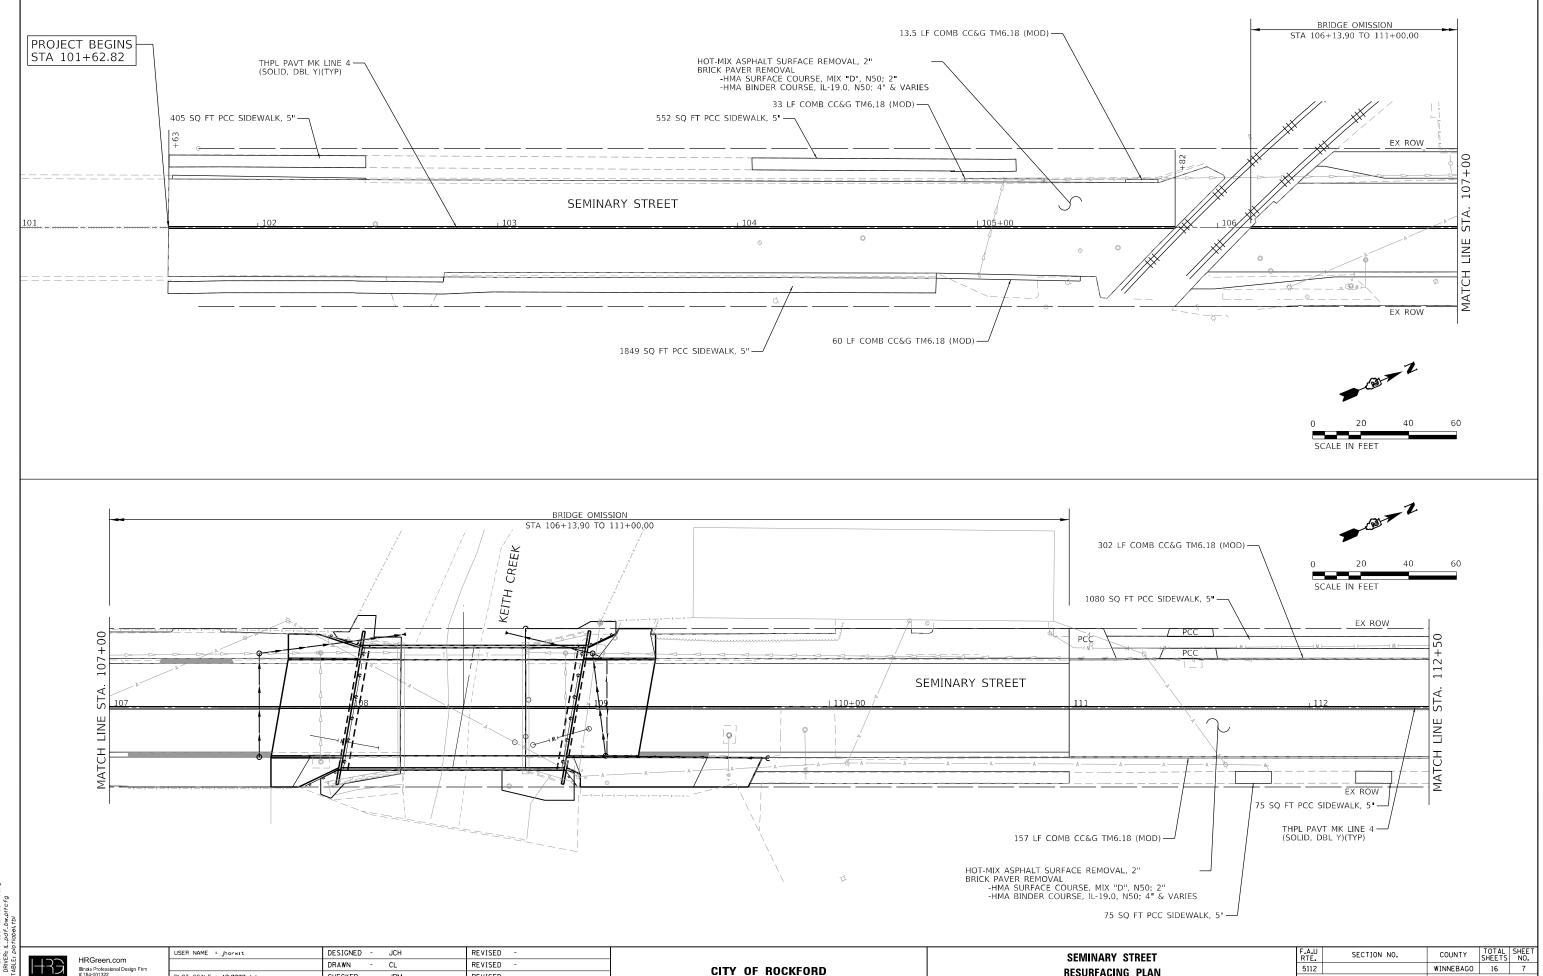


HRGreen.com HRGreen


DRAWN - CL REVISED CHECKED JRM REVISED PLOT DATE = 6/23/2022 DATE 6/22/2022 REVISED

CITY OF ROCKFORD

SEMINARY STREET 5112 **RESURFACING PLAN** CONTRACT NO. SCALE: 1"=20" SHEET 1 OF 2 SHEETS STA. 101+62.82 TO STA. 112+50 FED. ROAD DIST. NO. | ILLINOIS FED. AID PROJECT

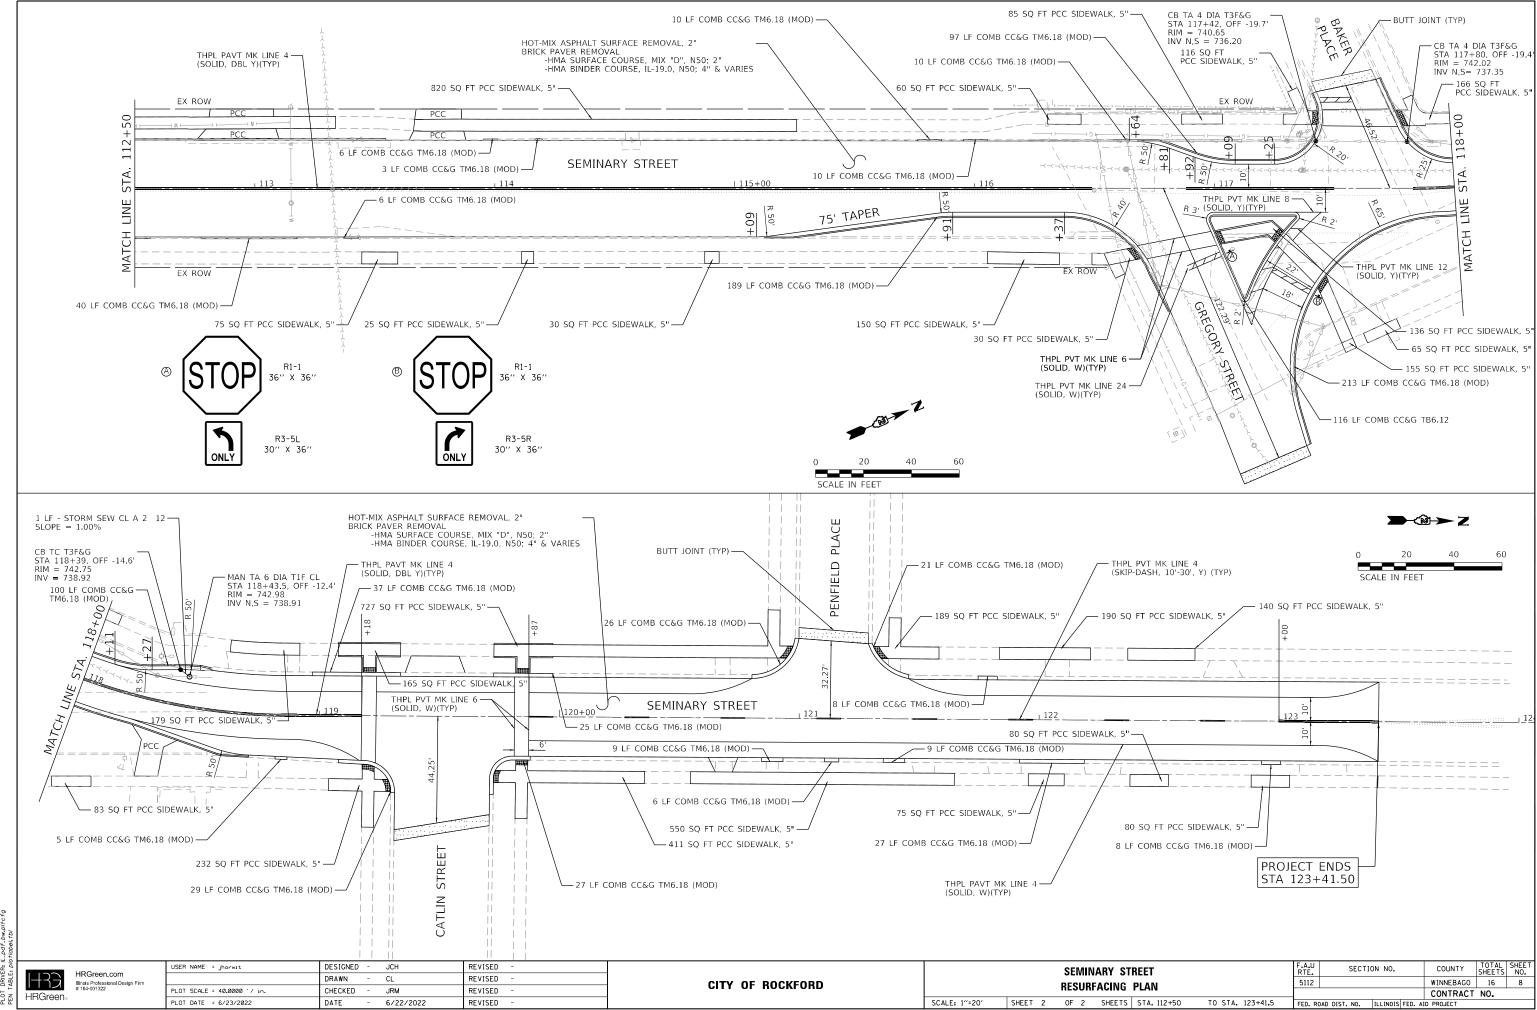

HRG PROJECT NO.; 180909
HRG PROJ. CONTACT:
FILE NAME: 180909.snt.resurt02.dgn
PLOT DRIVER: L.L.Ddf.bw.pltcfg
PEN TABLE: potriobel.tbi

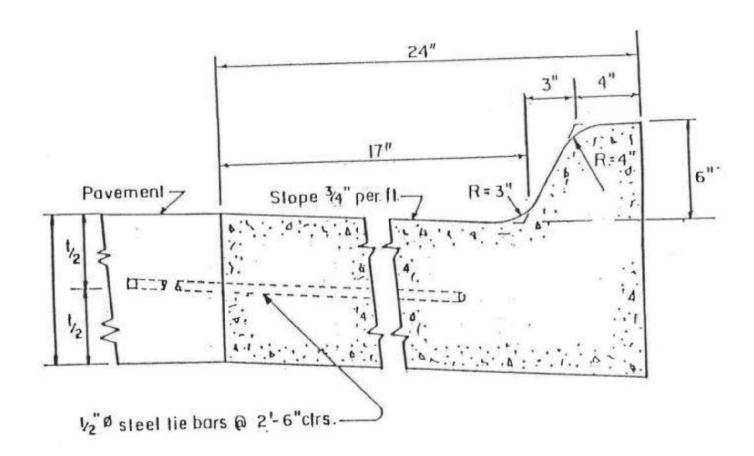

Combination Concrete Curb and Gutter Type M6.18 (Modified)

Figure 6-01

Department of Public Worl

HRC PROJECT NO., 180909 HRC PROJ. CONTACT: FILE NAME: 180909.s.n.t.det-Rockford PLOT DRIVER: IL_Ddf.bw.pitcfg PEN TABLE: plotdobei.tbi

HRGreen.com
Illinois Professional Design Firm
184-001322

USER NAME = jhorwit	DESIGNED -	REVISED -
	DRAWN -	REVISED -
PLOT SCALE = 2.0000 '/ in.	CHECKED -	REVISED -
PLOT DATE = 6/23/2022	DATE - 6/22/2022	REVISED -

CITY OF ROCKFORD

COMBINATION CONCRETE CURB AND GUTTER TYPE M6.18 (MODIFIED)

SCALE: N.T.S. | SHEET | 1 OF | 1 SHEETS | STA. TO STA.

F.A.U SECTION NO. COUNTY SHEETS NO.


5112 WINNEBAGO 16 9

CONTRACT NO.

FED. ROAD DIST. NO. | ILLINOIS | FED. AID | PROJECT

WORK ZONE SIGN DETAILS

ILLINOIS STANDARD G20–I100

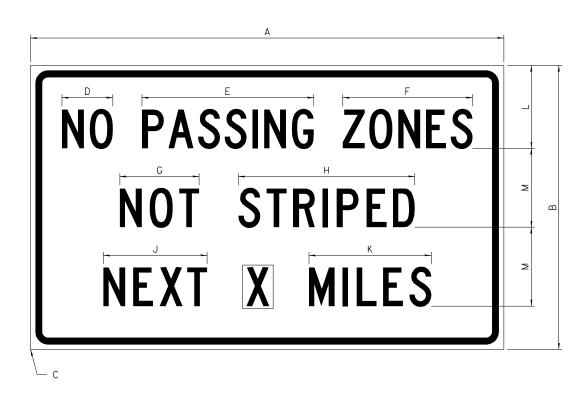

COLOR LEGEND AND BORDER BACKGROUND

BLACK ORANGE NON-REFLECTORIZED REFLECTORIZED

CION CITE					[DIMEN	SIONS	5				
SIGN SIZE	A B C D E F G H J K								L	М		
60 x 36	60.00	36.00	2.25	6.4	21.80	16.40	10.00	22.40	13.20	15.50	10.50	10.00

SIGN SIZE	SERI	ES BY	LINE	MADOIN	BODDED
SIGN SIZE	1	1 2 3 MARGIN		BORDER	
60 × 36	5C	5C	5C	0.625	0.875

Sign not to scale

GENERAL NOTES


All work to furnish and install these signs shall be included in the cost of the specified traffic control standards and shall not be paid separately.

All Illinois Standard signs shall conform to the latest edition of the "Illinois Standard Highway Signs Book" in effect on the date of invitation for bids.

Signs shall meet the applicable portions of Sections 701 and 720 of the Standard Specifications.

All dimensions are in inches unless otherwise noted.

ILLINOIS STANDARD W8–I107

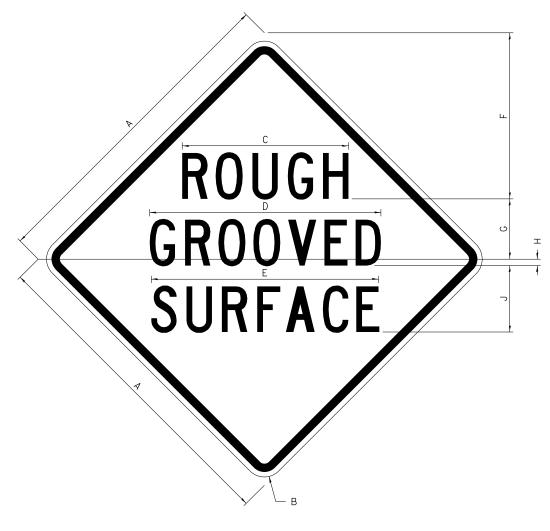

COLOR LEGEND AND BORDER BACKGROUND

BLACK

NON-REFLECTORIZED REFLECTORIZED

SIGN SIZE		DIMENSIONS									
31GN 31ZE	Α	В	С	D	Е	F	G	Н	J		
48 × 48	48.00	3.00	25.00	34.80	34.20	24.94	9.00	1.00	10.00		


SIGN SIZE	SERI	ES BY	LINE	MARGIN	BUDDED
SIGN SIZE	1	2	3	MARGIN	BORDER
48 × 48	7C	7C	7C	1.250	0.750

Sign not to scale

FILE NAME =	USER NAME = jhorwit	DESIGNED -	REVISED - 3-02-16				F.A.	SECTION	COUNTY	TOTAL SHEET
D2Standards.cel		DRAWN -	REVISED -	STATE OF ILLINOIS		REGION 2 / DISTRICT 2 STANDARD	11.12.			STILL 15 NO.
	PLOT SCALE = 2.0000 '/ in.	CHECKED -	REVISED -	DEPARTMENT OF TRANSPORTATION					CONTRACT	NO.
	PLOT DATE = 6/23/2022	DATE -	REVISED -		SCALE:	SHEET NO. OF SHEETS STA. TO STA.	FED. ROA	AD DIST. NO. ILLINOIS FED. A		

WORK ZONE SIGN DETAILS

ILLINOIS STANDARD W12-I102

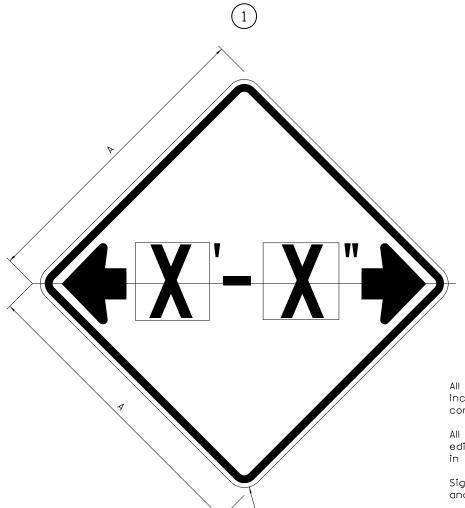

GENERAL NOTES

All work to furnish and install these signs shall be included in the cost of the specified traffic control standards and shall not be paid separately.

All Illinois Standard signs shall conform to the latest edition of the "Illinois Standard Highway Signs Book" in effect on the date of invitation for bids.

Signs shall meet the applicable portions of Sections 701 and 720 of the Standard Specifications.

All dimensions are in inches unless otherwise noted.

COLOR LEGEND AND BORDER BACKGROUND

BLACK FL ORANGE NON-REFLECTORIZED REFLECTORIZED


SIGN SIZE	DIMEN	SIONS
SIGN SIZE	Α	В
48 × 48	48.00	3.00

Illinois Standard signs W12-I102 and W12-I103 shall be used as described in the special provisions.

SIGN SIZE	SERIES BY LINE	MARGIN	BORDER	
SIGN SIZE	1	MARGIN	DORDER	
48 × 48	12C	0.750	1.250	

Sign not to scale

ILLINOIS STANDARD W12–I103

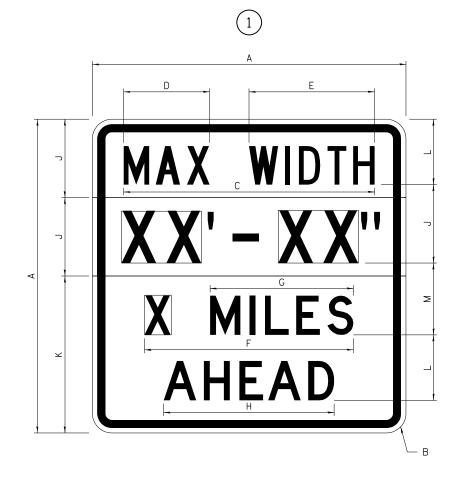

COLOR

LEGEND AND BORDER BACKGROUND BACKGROUND (WIDTH)

BLACK WHITE FL ORANGE

NON-REFLECTORIZED REFLECTORIZED REFLECTORIZED

SIGN SIZE						IMEN	SIONS	5				
SIGN SIZE	Α	В	С	D	E	F	G	Н	J	К	L	М
48 × 48	48.00	3.00	38.40	13.20	19.20	32.00	22.00	26.20	12.00	24.00	10.00	11.00

SIGN SIZE	S	ERIES	BY LIN	E	MARGIN	BUDDED
31GN 31ZE	1	2	3	4	MARGIN	BORDER
48 × 48	6C	8D	6D	6D	0.750	1.250

Sign not to scale

XX'-XX'' WIDTH AND X MILES ARE VARIABLE TOP AND BOTTOM OF BACKGROUND WHITE

FILE NAME =	USER NAME = jhorwit	DESIGNED -	REVISED - 3-02-16
D2Standards.cel		DRAWN -	REVISED -
	PLOT SCALE = 2.0000 '/ in.	CHECKED -	REVISED -
	PLOT DATE = 6/23/2022	DATE -	REVISED -

STATE OF ILLINOIS DEPARTMENT OF TRANSPORTATION

	REGION	2 /	DISTRICT	2 STANDARD
CCALE.	CHEET NO	ΟE	CHEETC	CTA

F.A. SECTION COUNTY TOTAL SHE

TO STA.

WORK ZONE SIGN DETAILS

ROAD CLOSED TO OVERSIZED LOADS



COLOR

LEGEND AND BORDER BACKGROUND


BLACK ORANGE NON-REFLECTORIZED REFLECTORIZED

Permit Loads - Loads Over 13 Feet; 3.0" Radius, 1.3" Border; [NO OVERSIZE -] D; [OVERWEIGHT LOADS] D 85% spacing; [XX MILES AHEAD] D; Table of letter and object lefts.

N 11.7	0 18.1	0 30.0	V 36.2	E 42 . 8	R 48.4	S 54.4	I 60.7	Z 63 . 5	E 69 . 5	- 80.8				
0 2.6	V 8.6	E 15.0	R 20.4	W 26.2	E 33.4	I 38.8	G 41.3	H 47.4	T 53.2	L 64.5	O 69.9	A 75.9	D 82.9	S 88.7
X 7.6	X 13.6	M 25.3	I 32.3	L 35.1	E 40.6	S 46.2	A 57.9	H 65 . 1	E 71.4	A 76.6	D 83.7			

Sign not to scale

STOP LINE SIGN FOR TEMPORARY SIGNALS

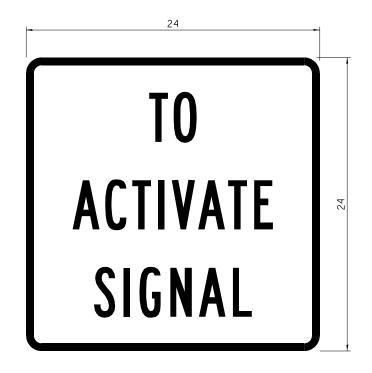

LEGEND AND BORDER BACKGROUND

BLACK WHITE

NON-REFLECTORIZED REFLECTORIZED

SIGN SIZE	SERIES BY LINE					
SIGN SIZE	1	2	3			
24 × 24	4C	4C	4C			

Sign not to scale

GENERAL NOTES

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All Illinois Standard signs shall conform to the latest edition of the "Illinois Standard Highway Signs Book" in effect on the date of invitation for bids.

Signs shall meet the applicable portions of Sections 701 and 720 of the Standard Specifications.

All dimensions are in inches unless otherwise noted.

FILE NAME =	USER NAME = jhorwit	DESIGNED -	REVISED - 3-02-16	
D2Standards.cel		DRAWN -	REVISED -	STATE OF ILL
	PLOT SCALE = 2.0000 '/ in.	CHECKED -	REVISED -	DEPARTMENT OF TRA
	PLOT DATE = 6/23/2022	DATE -	REVISED -	


LLINOIS RANSPORTATION

REGION 2 / DISTRICT 2 STANDARD SHEET NO. OF SHEETS STA.

COUNTY CONTRACT NO.

ENTRANCE SIGN FOR USE WITH TEMPORARY SIGNALS

WORK ZONE SIGN DETAILS

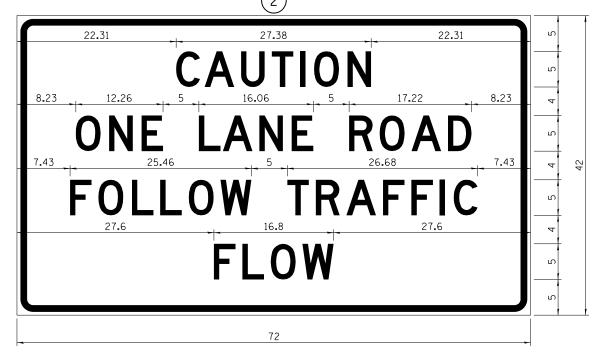

COLOR LEGEND AND BORDER BACKGROUND

BLACK ORANGE NON-REFLECTORIZED REFLECTORIZED

2.25" Radius, 0.88" Border, 0.50" IndenT; [CAUTION] D; [ONE LANE ROAD] D; [FOLLOW TRAFFIC] D; [FLOW] D

2 This sign shall be installed at entrances located between the temporary signals as shown in the staging plans.

Table Of Widths And Spaces

22.31	C 3.36	0.62	A 4.18	0.94	U 3 . 36	0.94	T 3.04	0.94	I 0.78	1.17	0 3.52	1.17	N 3.36	22.31
-------	-----------	------	------------------	------	--------------------	------	-----------	------	-----------	------	-----------	------	-----------	-------

	0		N		Ε
8.23	3 . 51	1.17	3.36	1.18	3.04

5.00	L 3.05	0.31	A 4.18	0.94	N 3.36	1.17	E 3.05
		l .				l	






5.00	T 3.05	0.94	R 3.36	0.94	A 4 . 18	0.93	F 3.05	0.94	F 3.04	0.94	I 0.78	1.18	C 3.35	7.43
------	-----------	------	-----------	------	---------------------------	------	-----------	------	-----------	------	-----------	------	-----------	------

	F		L		0		W	
27.60	3.05	0.94	3.04	0.94	3 . 52	0.93	4.38	27.60

Sign not to scale

STAY IN YOUR LANE

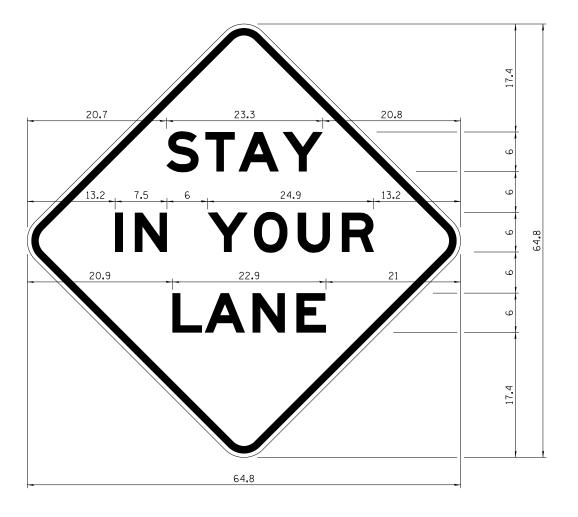

LEGEND AND BORDER BACKGROUND

BLACK ORANGE NON-REFLECTORIZED REFLECTORIZED

48.0" across sides 3.8" Radius, 1.0" Border, 0.6" Indent; "STAY" E Mod; "IN YOUR" E Mod; "LANE" E Mod;

Table of Letter and Object Lefts

S	Т	Α	Υ
20.7	26.8	31.6	38.0

I	Ν	Υ	0	U	R	ı
13.2	15.9	26.7	33.9	40.5	46.8	

L A N E 20.9 25.8 33.1 39.4

Sign not to scale

FILE NAME =	USER NAME = jhorwit	DESIGNED -	REVISED - 3-02-16	CTATE OF HUNDIC					SECTION	COUNTY	TOTAL SHEET SHEETS NO.
D2Standards.cel		DRAWN -	REVISED -	STATE OF ILLINOIS	REGION 2 / DISTRICT 2 STANDARD						5112215 1102
	PLOT SCALE = 2.0000 '/ in.	CHECKED -	REVISED -	DEPARTMENT OF TRANSPORTATION							NO.
	PLOT DATE = 6/23/2022	DATE -	REVISED -		SCALE:	SHEET NO. OF SHEETS STA. TO STA	A. F	FED. ROAD DIST. NO. ILLINOIS FED. AI			

GENERAL NOTESAll work to furnish and install these signs shall be included in the cost of the specified traffic control standards and shall not be paid separately.

All Illinois Standard signs shall conform to the latest edition of the "Illinois Standard Highway Signs Book" in effect on the date of invitation for bids.

Signs shall meet the applicable portions of Sections 701


All dimensions are in inches unless otherwise noted.


and 720 of the Standard Specifications.

TYPICAL PAVEMENT MARKINGS

MEDIAN PAVEMENT MARKING

TYPICAL PAVEMENT MARKING FOR FLUSH MEDIAN AT LEFT TURN LANE

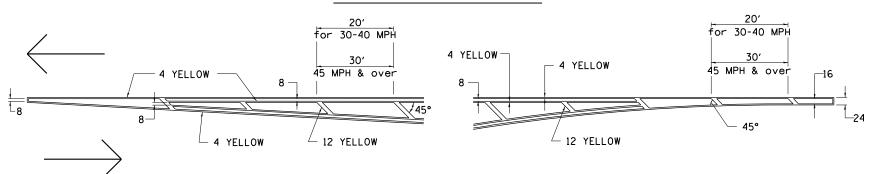

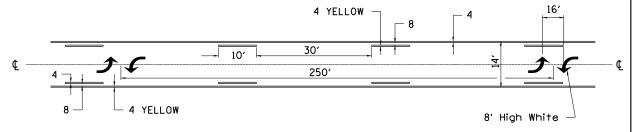

PAINTED ISLANDS


TYPICAL MARKING FOR

NOTE: * 45° TO LOCAL TAN. 24 WHITE STOP BAR 8 WHITE LANE LINE 45° ANGLE 8 WHITE THROUGH TRAFFIC

STANDARD CROSSWALK MARKING

.. ALL DIMENSIONS ARE IN INCHES UNLESS OTHERWISE NOTED.

See Schedules for Locations

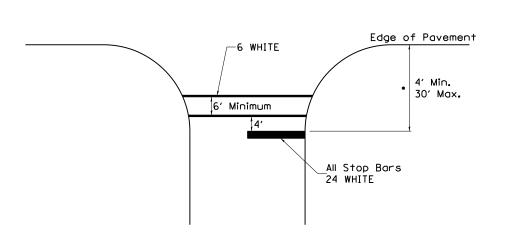

 Distance to the nearest edge of the intersecting roadway in the absence of a marked crosswalk.

FILE NAME = D2Standards.cel

5 Diagonals

Minimum

-12 WHITE

-8 WHITE

-24 WHITE

TYPICAL ISLAND

OFFSET SHOULDER WIDTH

24 WHITE -

8 WHITE

STATE OF ILLINOIS DEPARTMENT OF TRANSPORTATION REGION 2 / DISTRICT 2 STANDARD


SCALE: SHEET NO. OF SHEETS STA.

F.A. SECTION COUNTY TOT, SHEE

CONTRACT NO.


FED. ROAD DIST, NO. | ILLINOIS| FED. AID PROJECT


TO STA.

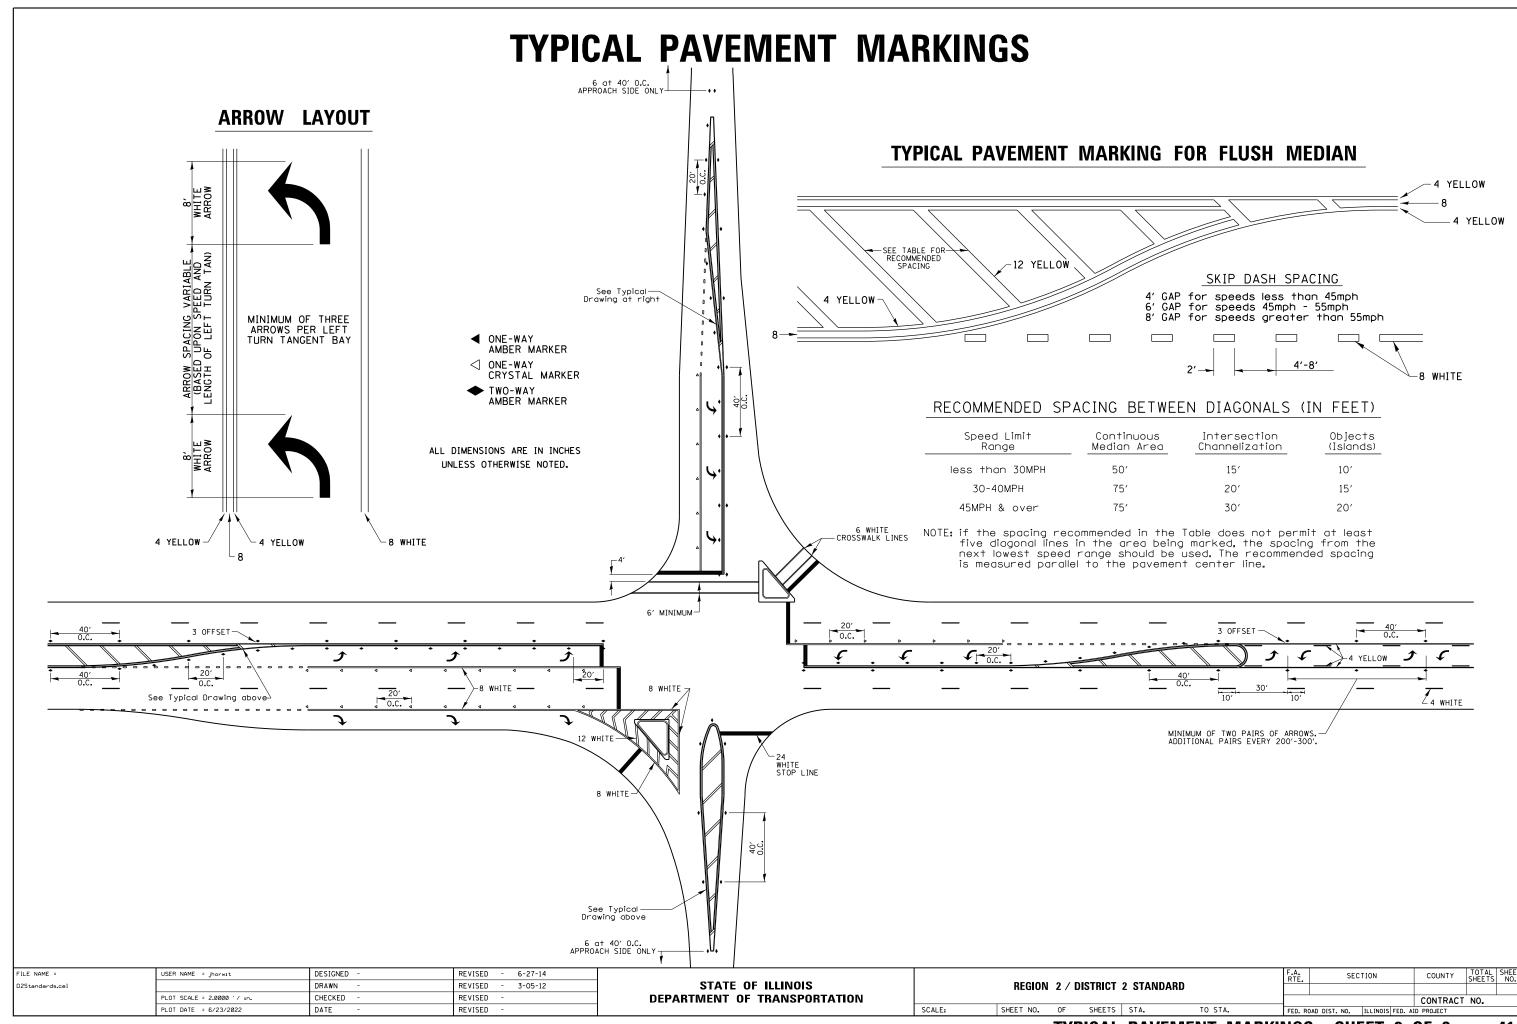

TYPICAL PAVEMENT MARKINGS


TYPICAL PARKING SPACING

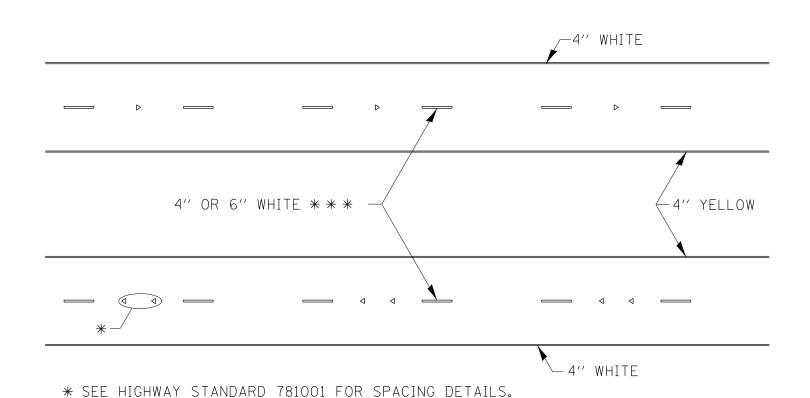

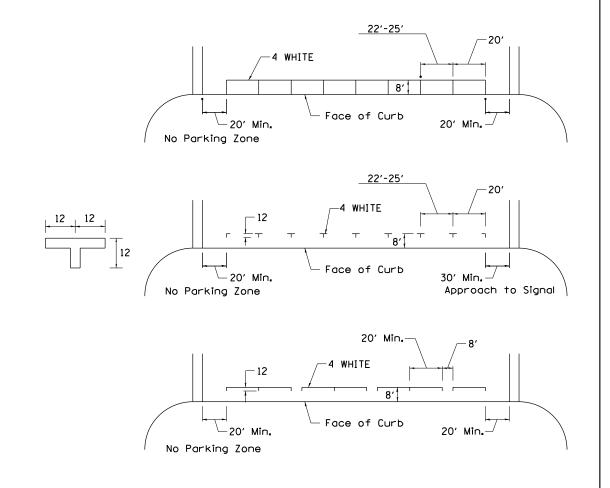

TYPICAL PAVEMENT MARKING FOR TWO LANE SECTION - NO PASSING ZONES

MULTI-LANE / DIVIDED

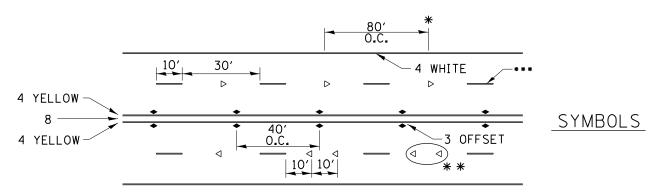

- REDUCE TO 40' O.C. ON CURVES WHERE ADVISORY SPEEDS ARE 10 MPH LOWER THAN POSTED SPEEDS.
- ** USE DOUBLE MARKERS WHEN ADT > 20,000

USE DOUBLE MARKERS WHEN ADT > 20,000.

*** CENTERLINE SKIP DASH PAVEMENT MARKING SPEED LIMIT LESS THAN 40 MPH USE 4" LINE. SPEED LIMIT 40 MPH AND OVER USE 6" LINE.

MULTI-LANE / UNDIVIDED & ONE WAY

(FOR MULTI-LANE UNDIVIDED HIGHWAYS USE THIS DETAIL NOT HIGHWAY STANDARD 781001)

FILE NAME = USER NAME = jhorwit DESIGNED REVISED - 6-27-14 SECTION COUNTY STATE OF ILLINOIS REVISED - 8-27-13 REGION 2 / DISTRICT 2 STANDARD D2Standards.cel DRAWN CHECKED REVISED 11-28-12 **DEPARTMENT OF TRANSPORTATION** CONTRACT NO. PLOT DATE = 6/23/2022 DATE SCALE: SHEET NO. OF SHEETS STA. TO STA. REVISED

30'

YELLOW

EDGE OF PAVEMENT

WHITE

WHITE-